


No.	Description	Date
5	Updated for planning	Date 5
6	Final Comments during planning	20/11/20
7	Planning NMA	27/12/20
8	Planning Rev	Dec 20
9	Planning Section 73	March 21
10	Section 73 Amend	May 21
11	Revision 11	May 21


CODE STATUS SUITABILITY DESCRIPTION PURPOSE OF ISSUE Prop Site / F					The Wi
	CODE	STATUS	SUITABILITY DESCRIPTION	PURPOSE OF ISSUE	

The Windmill	Owner				
	Date Issue Date	Project number Project Number	Scale (@ A3) 1 : 200		
ET	Drawn by	DRWAING NUMBER	R	łΕ	
rop Site / Roof Plans	Author Checked by WS	A101			


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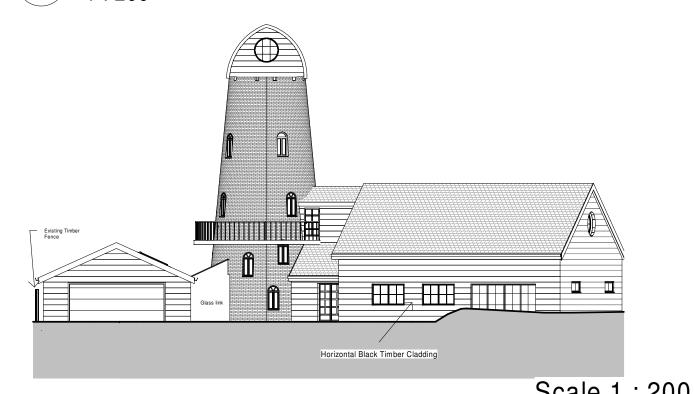




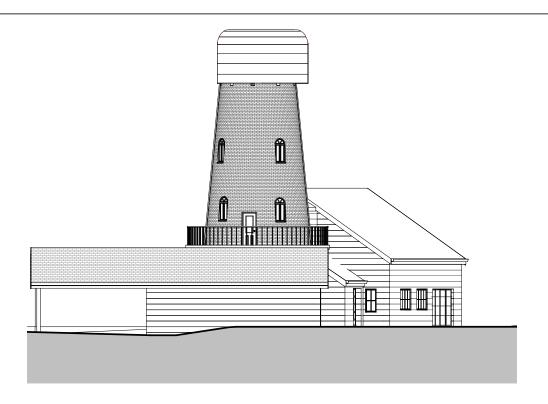

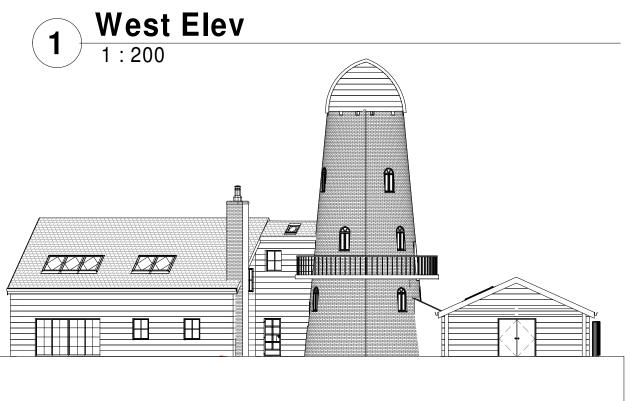


2 East Elev 1:200

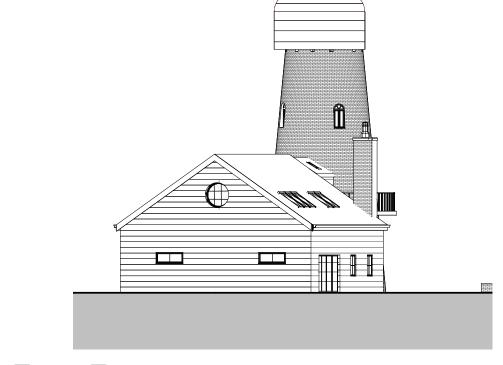

South Elev		Stale	31.200
1:200	0 2 4	10	20 m


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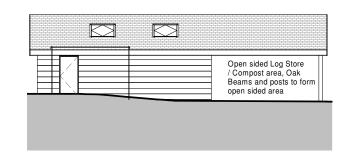
				The Windmill	CLIENT	Owner			
					Date Issue Date	Project number Project Number	Scale (@ A 1 : 200	.3)	
CODE	STATUS	SUITABILITY DESCRIPTION	PURPOSE OF ISSUE	Drop Florations	Drawn by Author	DRWAING NUMBER		REV	
				Prop Elevations	Checked by Checker	A104		11	

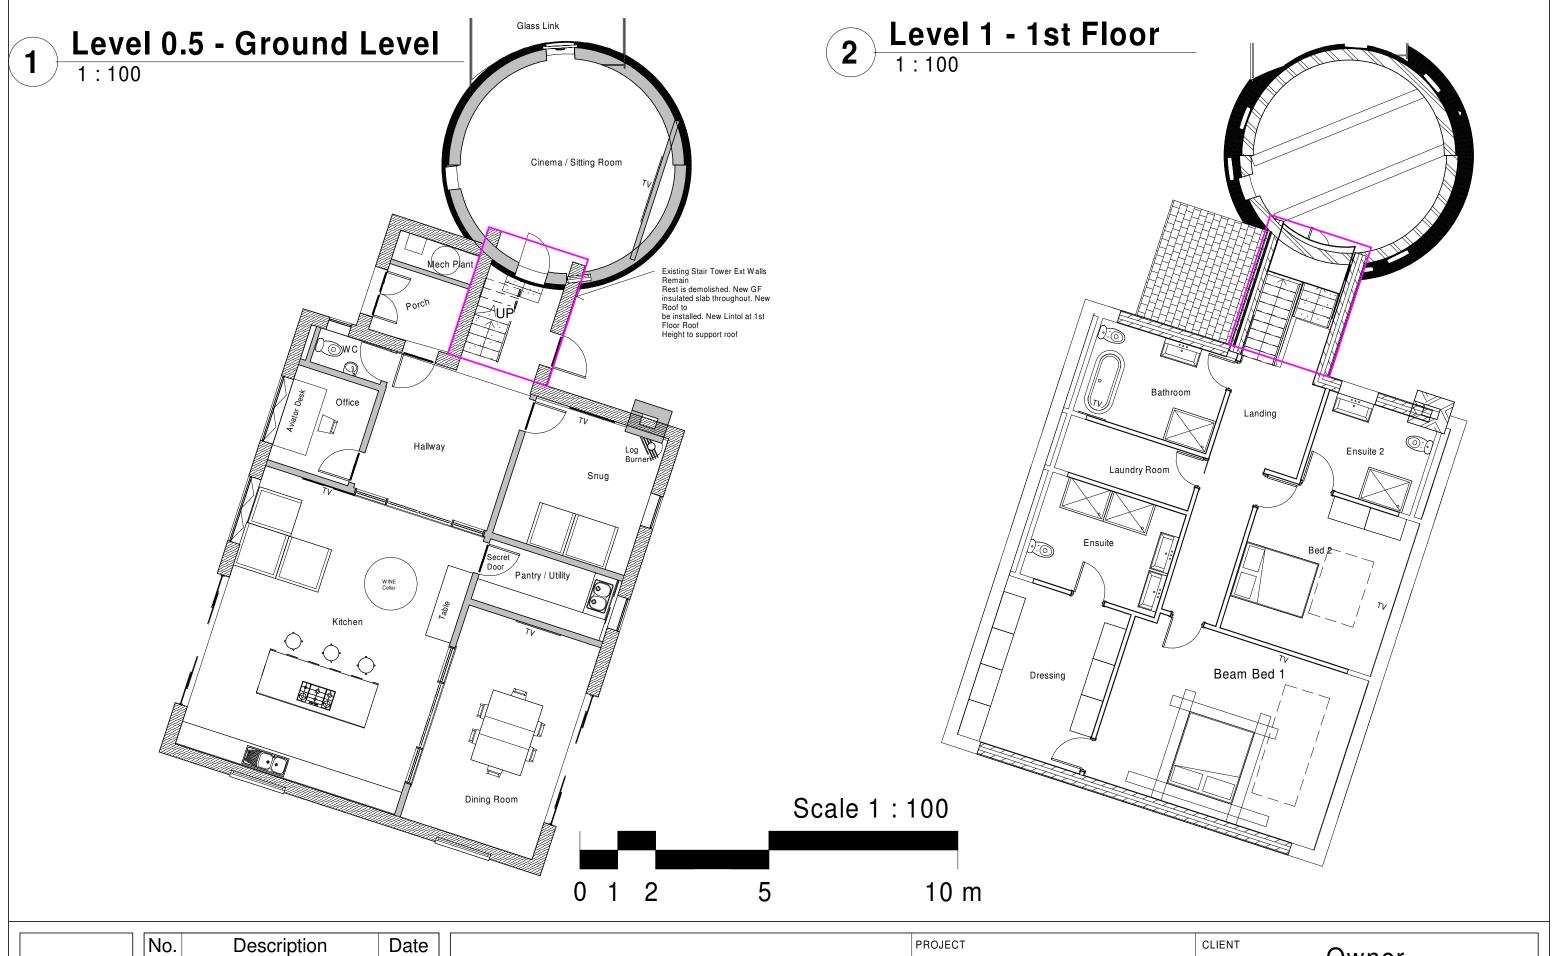



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CODE STATUS SUITABILITY DESCRIPTION PURPOSE OF ISSUE Prop Floor Plans 1 The prop Floor Plans 1 Date Project number Project Number 1:100 Drawn by Author Plans 1 Date Project number Project Number 1:100 Drawn by Author Plans 1					The Windmill	CLIENT	Owner		
CODE STATUS SUITABILITY DESCRIPTION PURPOSE OF ISSUE Prop Floor Plans 1 Prop Floor Plans 1 Author Checked by A102						Issue Date	Project Number	, -	
	CODE	STATUS	SUITABILITY DESCRIPTION	PURPOSE OF ISSUE		Author			





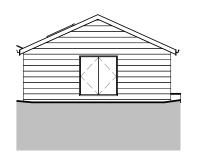

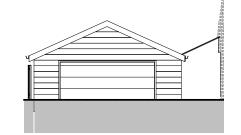


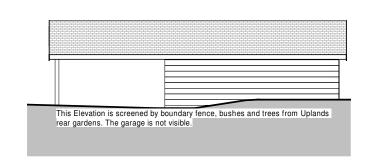Garage North Elev

Garage East Elev 1:200

Garage South Elev 1:200

Garage West Elev 1:200

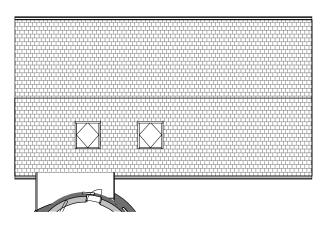

Garage / Workshop Canopy

Red = Replacement Garage approved under previous planning permission

Blue = Cantilevered Roof Extension to create Bin Store / log store / garden waste / compost area. Existing ground levels and finish remain within Blue zone and open sided construction. Pad Foundations at 600x600x600 post as AIA Report

Canopy Materials.
Timber 200x200 posts / beams structure with Black timber cladding / soffits / Gable end / Fascias as Garage. Roof tile as approved garage plans, Heritage tile

Level 3 Garage / Canopy Roof

Garage Canopy

Scale 1:200 0 2 4 10 20 m

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CODE	STATUS	SUITABILITY DESCRIPTION	PURPOSE OF ISSUE	SHEET	Drawn by Author	DRWAING NUMBER		REV	7 5
				Prop Garage Canopy	Checked by Checker	A105		10	06/90/0



All Pitched Roofs within plot including garage canopy

Heritage Clay Conservation Weathered Tile



Windmill House Extension Cladding -Horizontal Black Timber - with black garage door



Windmill Tower Windows

The existing steel frames are to be shotblasted and re painted White. New slim Double Glazed units inserted that are 14mm thick with lime putty and white spacer in square openers. The 3nr Fan light sections at the top are 1970's glass, these will be retained. These square windows are from the 1970's conversion and not original 1860's windows or glass. The inner modern sections of the windows appear to be inserted into old iron frames in the 1970's with modern glass. We don't believe replacing the 1970's glass additions with double glazed units is a loss of historic fabric.

Extension new and

windows (not tower)

Crittal type double glazed windows to match windmill tower in black RAL

replacement

9005



Windmill Tower will have Rockwall floor and ceiling cavities that are enclosed. No wall



Windmill external brick walls to be finished with a lime plaster. internally

insulation is being




All Roof Lights

Black Velux GGU Solar powered Roof Lights. Installed with a recessed kit



Fascias and Soffits - Black Timber

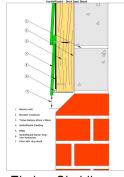

Timber Cladding Dwarf Wall section bricks as approved

Cellweb Tree Root

Protection -


installed as site plan drawing

2.

Timber Cladding Materials Product Ref 2 - Black painted timber feather edge Cladding to non boundary elevations of the garage and the house extension. 175mm x 18mm thick horzontally fixed.

Garage elevation will be product Ref

Zeroflame Fire Retardant Treatment by Zero flame Reference ZFP400168 Soaks virtually into woods and timber Achieves Euroclass B (BS Class Fire Propagation and Spread of Flame fire protection on solid timbers Can be overcoated for decorative

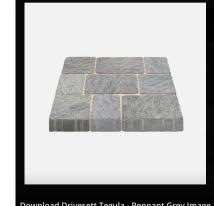

Block Paving paths / patios

Marshalls Drivesett Tegulla



Prevents compaction of sub soils
 Only guaranteed system of its kind on the

• Reduces sub base depths • Independently tested Environmentally friendly
 Simple to install Historic Photo of The Windmill Tower

Cladding to New Tower Cap walls will be timber horizontal clad natural to match the original attached buildings.



1.



Woodstone 28mm Bird Box 2nr works complete



2 x Crevice dwelling boxes such as the Vivara Pro woodstone self maintaining box



1 x Large chamber to support void dwelling bats and larger numbers of




Condition Discharge - Boxes erected on site DEC 2020








Historic Photos of Previous Windmill Cap blown off in storm damage around 1900

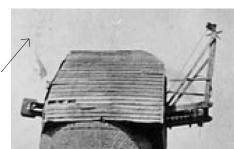

Owner



External doors to Kitchen / Dining room - Crittal type in Black RAL 9005 as windows. See window and door details enclosed

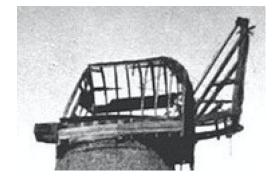

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All historic timber floor beams to remain throughout tower.

There are no remaining historic features within the

tower, these are believed to

have removed prior to the

PROJECT CLIENT The Windmill Date Project number Issue Date **Project Number** SHEET Drawn by DRWAING NUMBER CODE SUITABILITY DESCRIPTION PURPOSE OF ISSUE **STATUS** Author **Prop Materials** Checked by A106 Checker

Scale (@ A3)

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10

Please refer to Drawing A113 for location of Service items for Condition

Light Ref L

Fan Extract Ref V

RWP Gutter Ref G

RWP DownPipe Ref DP **CCTV Camera Ref C**


These have been installed in locations on site as Ecologist report. 1nr Large and 2nr Vivara Pro

Bat Boxes installed to discharge condition C7

External Wall Light



Bulkhead Outdoor & Bathroom Round Ligh

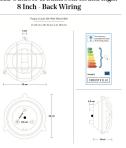


Dark Pewter Metal Finish

Black RAL 9005





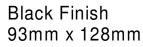

Conservation Weathered



Chimney Pot Details




All Roofs - Heritage Tile Ltd - Conservation Weathered Tile & Black Timber Cladding, shown with black windows as proposed


Large Multi Chamber WoodStone Bat Box Vivara Pro WoodStone Bat Box



For vents that are linked to rooms in 1st Floor, the vent will be partially hidden in elevation by the fascia and

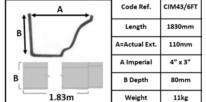



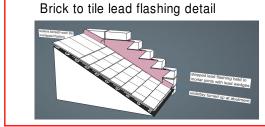

All Foul water pipes are internal to the extension leading to underground pipework, so not shown on external facade They are either concealed internally by plasterboard boxing / Kitchen casework / Vanity Units within Bathrooms.

Black Vent 100x100mm

roof structure

External services are shown on drawings enclosed with specification and sizes above. This includes RWP downpipes

There is no Alarm box to be installed on the property

TV / Satellite Dish

This is existing on the stair tower and no change proposed from what is installed already.

Virgin Media is the existing broadband provider and this is installed underground to low level brown box at 100mm off the ground and is currently installed. There is no BT overhead connection planned or existing.

As the Windmill is an existing residential property, upgrading to meeting certain latest building regulations is not required due to its listed status. The Building Regulations only apply to new work and there is no general requirement to upgrade all existing buildings to meet these standards. Where a building did not comply with the Regulations before the alteration the work of alteration shall be carried out so that afterwards the building's compliance with the Regulations is no more unsatisfactory Replacement dividing walls and doors will be replacing existing plasterboard walls to meet 30 mins fire separation to ensure fire compartmentation as best practice detailed provided. Additional means of escape is provided by including the timber balcony

here is no requirement to upgrade for any acoustic requirements / access / energy in relation to the heritage part

There is an existing wireless smoke and fire alarm system installed within the property windmill. This is a monitored system and no changes are proposed with the new scheme within the Tower. The new extension will meet new regulations is required, but these does not apply to the listed building condition that requires discharging.

Pitched / Flat Roof Demo and Brickwork Repairs

The existing flat roof will be removed by hand where it attaches to the Windmill tower. Its likely no repairs are required with this method, but this will then be cleaned down by hand and any brickwork and lime mortar repairs will be carried out as previously approved method statemen for the Brickwork repairs under application 20/2036/LBC. The brickwork will be repaired to the same line as the existing curve if required.

New Internal division walls to Windmill Tower

30min fire rating Plasterboard wall with 30min Timber Fire doors

Plasterboard Division walls with 2 layers of 12.5mm Gyproc board as detail below with plaster skim finish and painted wh



Two layers of board each side of 48mm Gypframe 'C' Studs at 600mm centres. 25mm Isover Acoustic Partition Roll (APR 1200) in the cavity. Linings as in table.

Howdens Dordogne White


30 Min Fire Door to Windmill Tower

Glass Link

Example showing between Garage and Windmill

Product as photo and connect details to wall and floor as



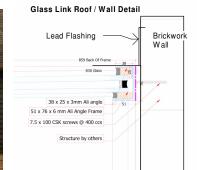





The bricks and mortar materials to be used for any repairs are as the previously approved application 20/2036/LBC also. The new pitched tile roof will be lead dressed into the Brickwork and the pointed with the approved lime mortar as detail above.


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	Prop Materials 2	Checked by Checker	A119		11	






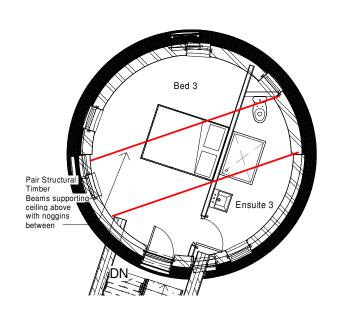


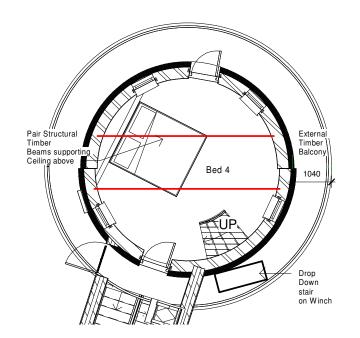
2 Level 1.2 - Bed 3 Tower

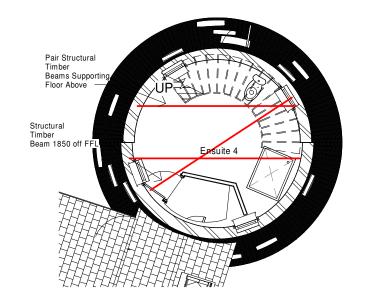1 Level 1.3 - Bed 4 Tower

3 Level 1.4 - Ensuite 4

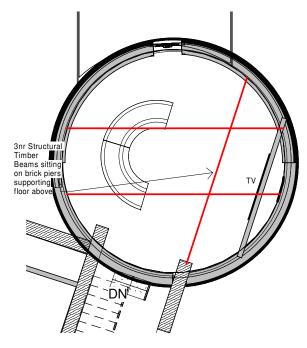

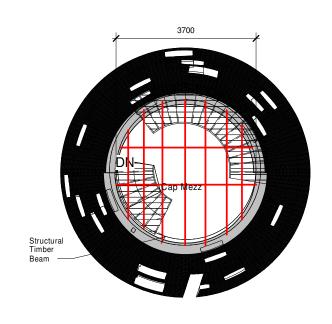

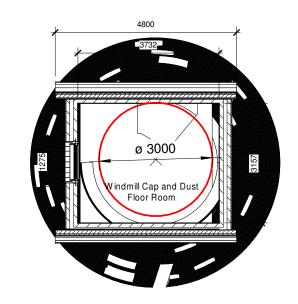

Level 1.1 - Cellar

5 Level 1.5 - Tower Mezz

4 Level 1.6 Windmill Cap

1:100
Scale 1:100

0 1 2 5 10 m

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				PROJECT The Windmill	Owner			
		Issue Date		Scale (@ A3) 1:100				
CODE	STATUS	SUITABILITY DESCRIPTION	PURPOSE OF ISSUE	Prop Floor Plans 2	Drawn by Author Checked by Checker	A103		10