




Scale: 1:1250 | Area 2Ha | Grid Reference: 506792,195297 | Paper Size: A4

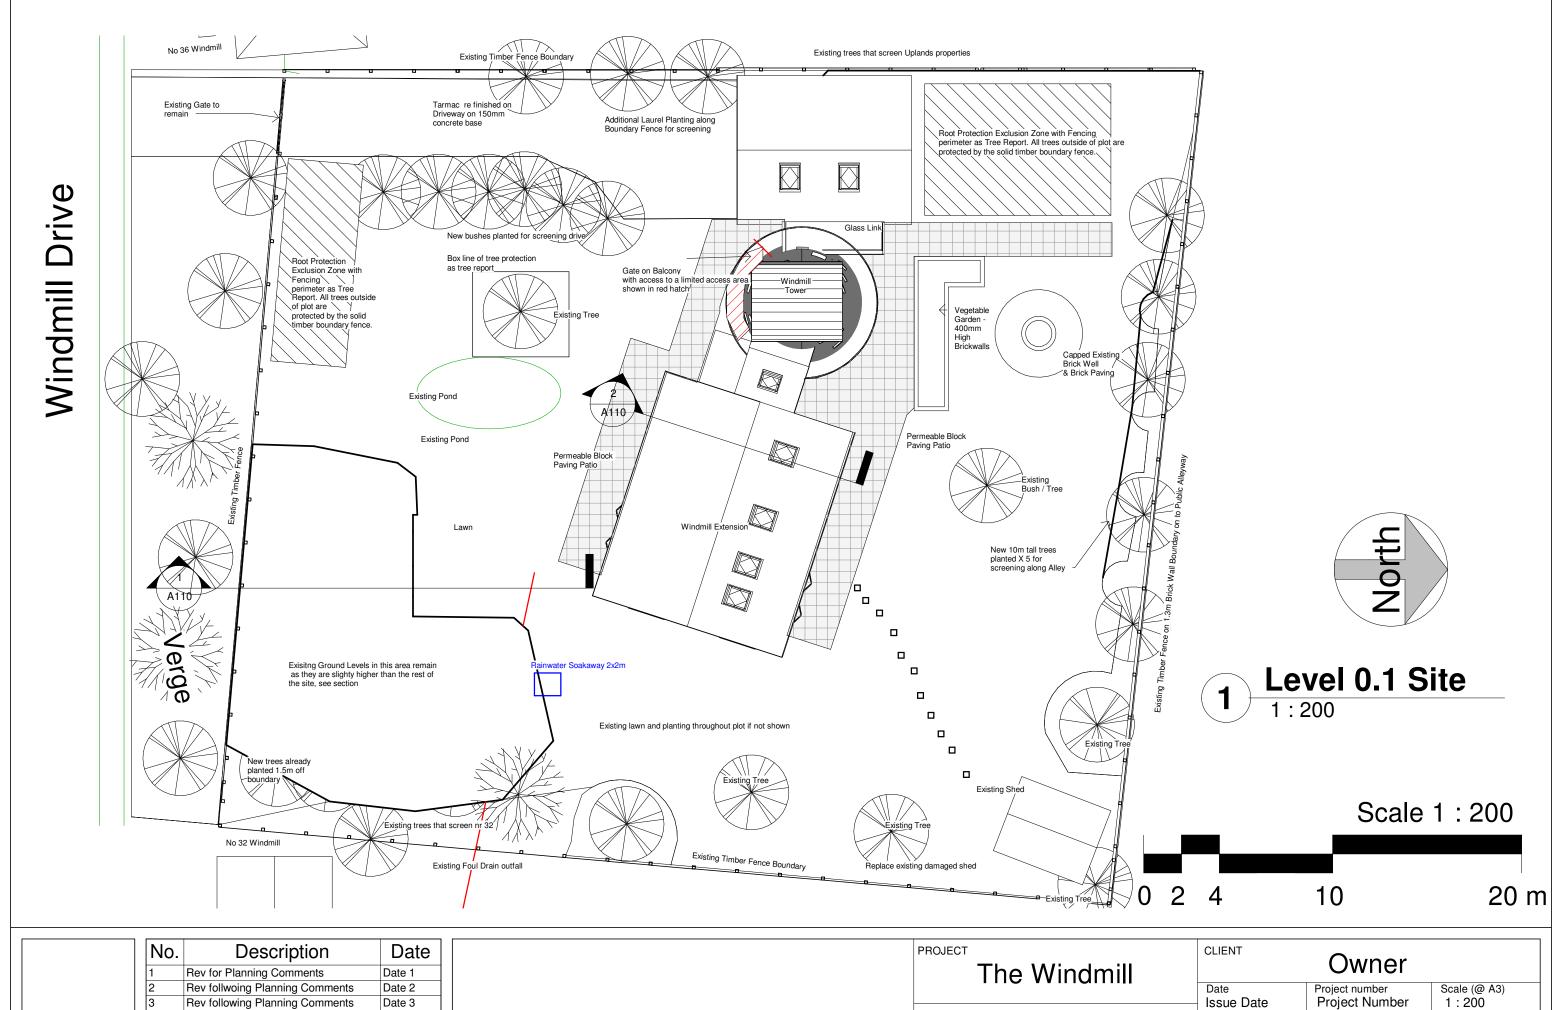



SUITABILITY DESCRIPTION PURPOSE OF ISSUE

Rev following Planning Comments

Final Comments during planning

Updates following planning site Visit

Date 3

Date 4

20/11/20

CODE

**STATUS** 

26/11/2020 20:18:31

REV

5

Project Number

DRWAING NUMBER

A101

Drawn by


Author


Checked by WS

Proposed Site / Roof


**Plans** 

1:200

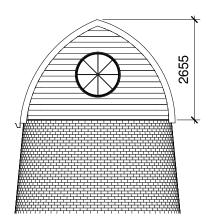


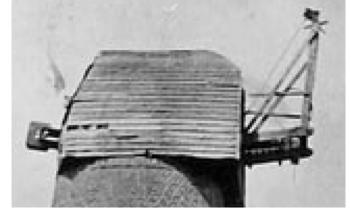

**Previous Windmill Cap Photo** 

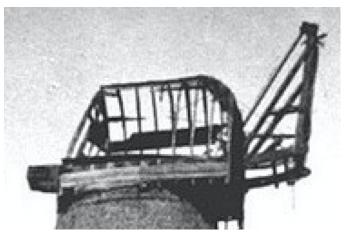

**Previous Windmill Cap with no cladding** Photo

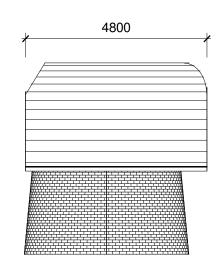


Historic photos show one end of the cap over sailing the brickwork ring by APPROX 400mm, and flush at the opposite end. This has been included in the new cap.

There would have been a door to access the fantail originally, this is now proposed to be a square window.

## **Tower Cap End Elev**

The height of the cap can be compared in the photo to the GF Door opening and overpanel as this opening is on site which is 2.5m tall. The 1st Floor door below is 2m tall which gives you the scale to determine the height of the cap for its replacement.

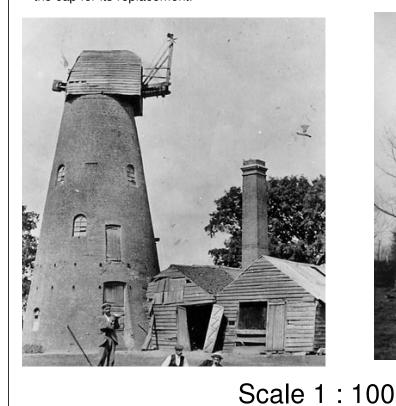

Historic photo showing base of original cap with overhang below



10 m





Other Examples of Boat Caps to **Tower Windmills within the UK** 





Looking West to Uplands

Taken Mid Nov 20 with evergreen bushes etc

## Tower Cap Side Elev

## **New Cap Details & Materials**

Cap to be constructed from a timber structure and insulated to modern standards. Horizontal timber finish as research photos

Windows to be finished white to match Windmill tower windows below

New walls & Roof to be clad in timber Horizontally to match original cap

Tower Cap to face property gate

Below shows the views from 3 of the highest existing windows in the Tower, as you can see due to the height of the original tower there is already overlooking, therefore adding a new window above in the replacement cap does not increase the overlooking and as such does not affect the privacy levels of neighbouring properties. Additional planting has been included to screen along South and North Boundaries

All surronding properties are at least 28m away from the Windmill Tower centre with nr 42 being 70m away.



Looking South



Looking North Additional tree planting included along this elev



Looking West to Uplands Taken in Sept 20

The new cap is not higher than the boundary trees and these limit the views considerably. The proposed scheme also includes new trees on the North, east and west elevations to assit in screening.

No.	Description	Date
1	Rev for Planning Comments	Date 1
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3	Rev following Planning Comments	Date 3
4	Updates following planning site Visit 28/9/20	Date 4
5	Updated for planning	Date 5
6	Final Comments during planning	20/11/20


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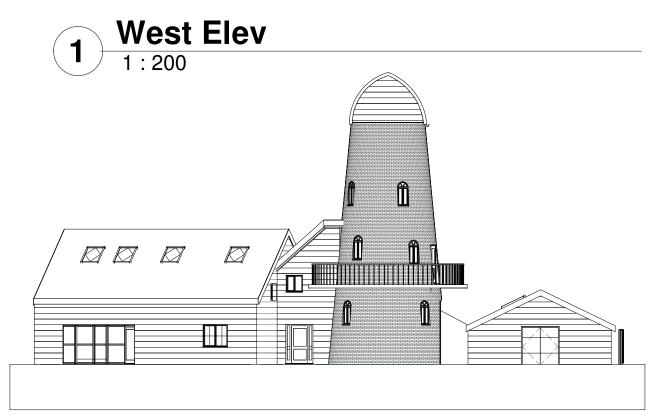
CODE	STATUS	SUITABILITY DESCRIPTION	PURPOSE OF ISSUE

PROJECT	
	The Windmill


Windmill Cap Details

CLIENT	Owner		
Date	Project number	Scale (@ A	3)
Issue Date	Project Number	1:100	
Drawn by	DRWAING NUMBER		REV
Author			
Checked by Checker	A109		6




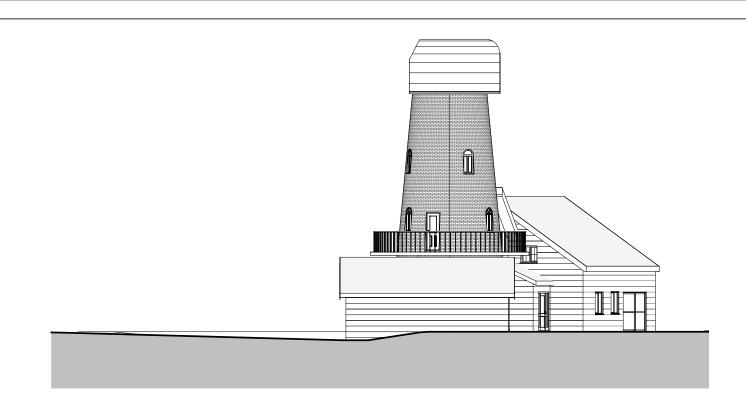

3 North Elev 1:200

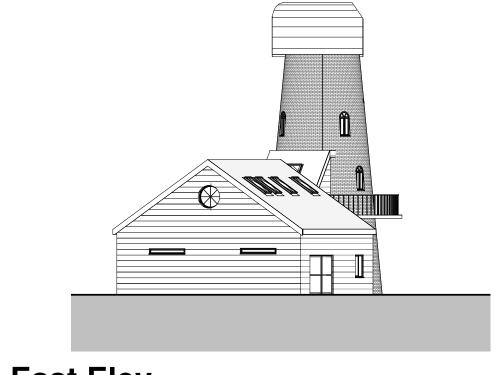

2 East Elev 1:200

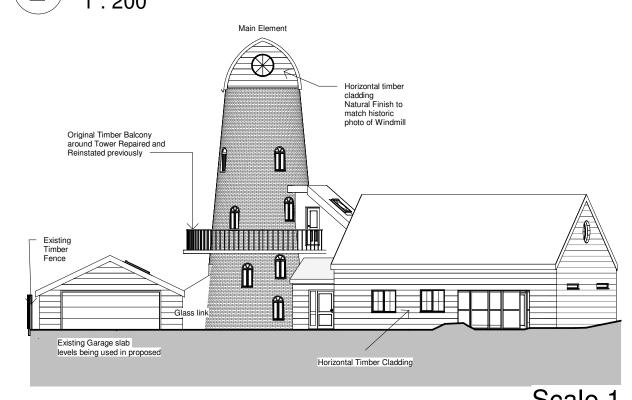

Scale 1 : 200


South Elev

1 : 200


0 2 4 10 20 m

No.	Description	Date
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				The Windmill	CLIENT	Owner		
					Date Issue Date	Project number Project Number	Scale (@ A3) 1:200	
CODE	STATUS	SUITABILITY DESCRIPTION	PURPOSE OF ISSUE	SHEET	Drawn by Author	DRWAING NUMBER	REV	
				Proposed Elevations	Checked by Checker	A104	6	

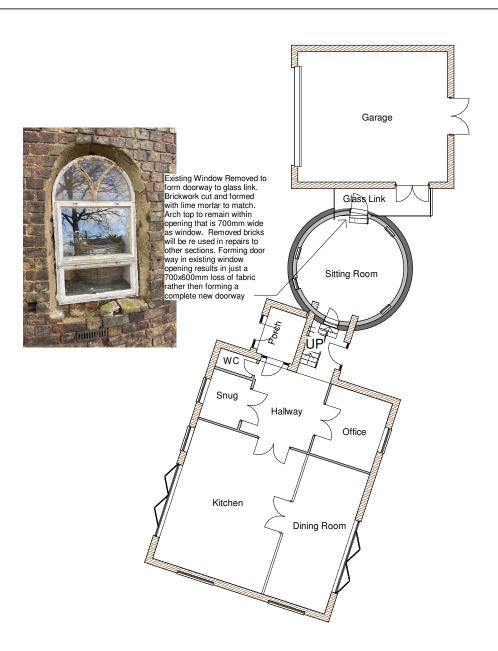

Level 0.5 - Ground Level

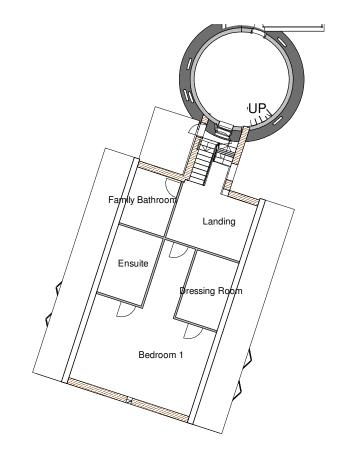


**2** Level 1 - 1st Floor




No.	Description	Date
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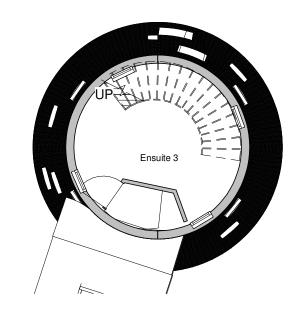
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	OTATOO	GOTTABLETT BESOME TION	1 0111 00E 01 1000E	Proposed Floor Plans 1	Author Checked by Checker	A102	6	



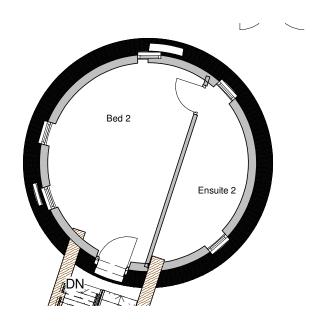


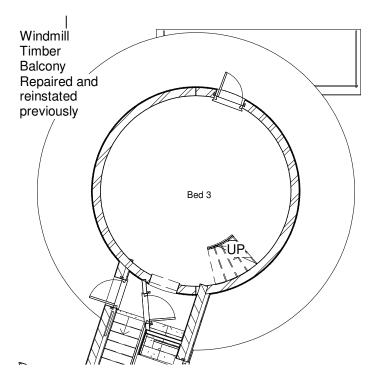

1 Level 1.3 - Bed 4 Tower



3 Level 1.4 - Ensuite

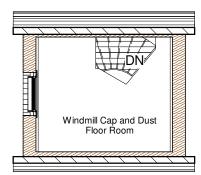


Scale 1:100 0 1 2 5 10 m


4 Level 1.6 Windmill Cap


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<b>)</b>					The Windmill	CLIENT	Owner		
						Date Issue Date	Project number Project Number	Scale (@ A3 1 : 100	3)
	CODE	STATUS	SUITABILITY DESCRIPTION	PURPOSE OF ISSUE	SHEET	Drawn by	DRWAING NUMBER		REV
					Proposed Floor Plans 2	Checked by Checker	A103		6



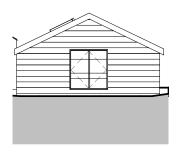



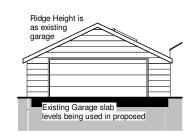

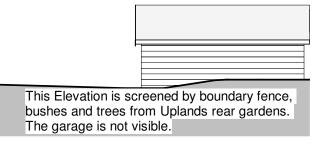Garage North Elev


1:200


**Garage East Elev**1:200

Garage South Elev
1:200

Garage West Elev

1:200

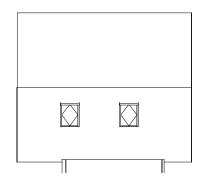

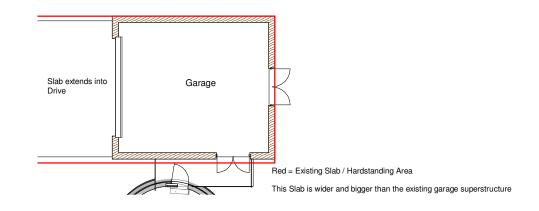

6 Level 3 Garage / Shed Roof

**Garage Foundation Area**1:200

Scale 1:200 0 2 4 10 20 m

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				The Windmill	CLIENT	Owner		
					Date Issue Date	Project number Project Number	Scale (@ A3) 1:200	
CODE	STATUS	SUITABILITY DESCRIPTION	PURPOSE OF ISSUE	Dropood Coroso	Drawn by Author	DRWAING NUMBER	REV	
				Proposed Garage	Checked by Checker	A105	6	



All Pitched Roofs wihtin plot

Heritage Clay Plain Roof Tile - Classic Victorian



Windmill House Extension Cladding -Horizontal Black Timber - with black garage door



Windmill Tower Windows

The existing steel frames are to be shotblasted and re painted White. New slim Double Glazed units inserted that are 14mm thick with lime putty and white spacer in square openers. The 3nr Fan light sections at the top are 1970's glass, these will be retained. These square windows are from the 1970's conversion and not original 1860's windows or glass. The inner modern sections of the windows appear to be inserted into old iron frames in the 1970's with modern glass. We dont believe replacing the 1970's glass additions with double glazed units is a loss of historc fabric.



9005



Windmill Tower will have Rockwall floor and ceiling cavities that are enclosed. No wall insulation is being



Windmill external brick walls to be finished with a lime plaster. internally



Heavy gauge steel bracket - up to 50mm of adjustment for levelling.


All Roof Lights

Black Velux GGU Solar powered Roof Lights. Installed with a recessed kit to set rooflight flush with roof tile




Fascias and Soffits - Black Timber

Metal black Rainwater goods.

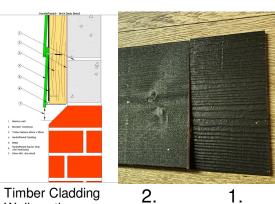

Wall section

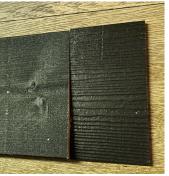

feather edge Cladding to non boundary elevations of the garage and the house extension.

Midnight Black.

visible timber grain

**Timber Cladding Materials** 

Product Ref 1- for Garage Boundary

elevation & Windmill Tower Cap -Product - Hardiplank Cedar Cement

Fibre (Timberlook a like) Colour -

Non-combustible cladding - with

Non-combustible, achieving the highest rating possible (A2, s1-d0) for a coloured facade product.

Product Ref 1 - Black painted timber



Block Paving paths / patios

Marshalls Drivesett Tegulla



Prevents compaction of sub soils
Only guaranteed system of its kind on the

Reduces sub base depths
Independently tested
Environmentally friendly
Simple to install

Historic Photo of The Windmill Tower

Cladding to New Tower Cap walls will be timber horizontal clad natural to match the original attached buildings.






Woodstone 28mm Bird Box. 2nr installed within the grounds when works complete



2 x Crevice dwelling boxes such as the Vivara Pro woodstone self maintaining box



1 x Large chamber to support void dwelling bats and larger numbers of

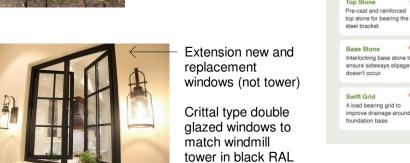



All historic timber floor beams to remain throughout tower. There are no remaining historic features within the tower, these are believed to have removed prior to the




External doors to Kitchen / Dining room - Crittal type in Black RAL 9005 as windows. See window and door details enclosed

Replacement Shed

Above ground

Foundation detail

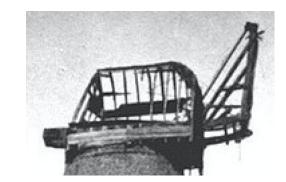


Historic Photos of Previous Windmill Cap blown off in storm damage around 1900




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· ·		The Windmill	Owner				
					Date Issue Date	Project number Project Number	Scale (@ A3)
CODE	STATUS	SUITABILITY DESCRIPTION	PURPOSE OF ISSUE	SHEET	Drawn by	DRWAING NUMBER	REV
0052				Proposed Materials	Author		
				Froposed Materials	Checked by Checker	A106	6

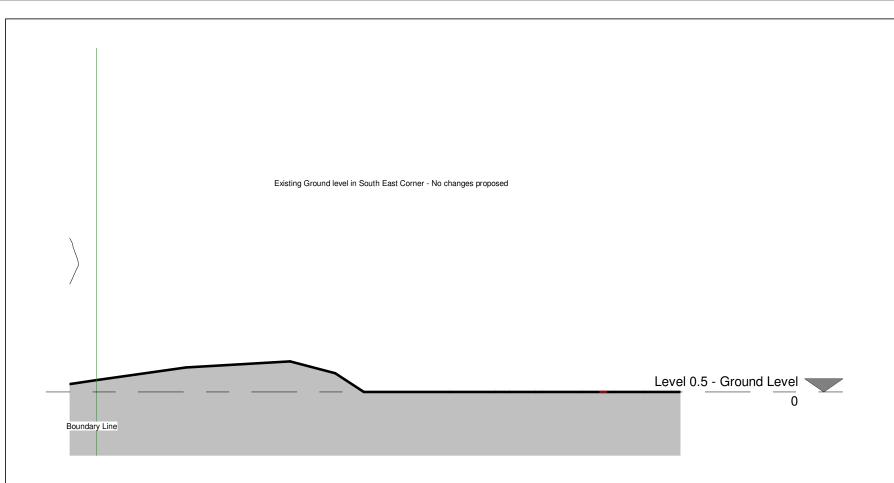

South East Ground Site Corner

1:100

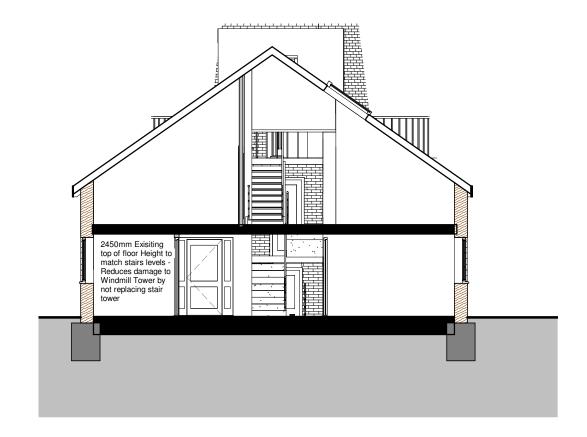

**New Extension Section**1:100

No.	Description	Date
1	Updates following planning site Visit 28/9/20	Date 4

				The Windmill	The Windmill	Owner			
						Date Issue Date	Project number Project Number	Scale (@ A3 1:100	,)
CODE	STATUS	SUITABILITY DESCRIPTION	PURPOSE OF ISSUE	SHEET	Castions	Drawn by Author	DRWAING NUMBER		REV
					Sections	Checked by Checker	A110		1