

LOCATION PLAN



Project: Coral Gables Solesbridge Lane Chorleywood WD3 5SN Drawing: Location Plan Scale: 1:1000 @ A3 Drawing Number: **0001** Date: May 2021 Status: PLANNING Revisions: A:00.00.00 - Revisions.



80

100



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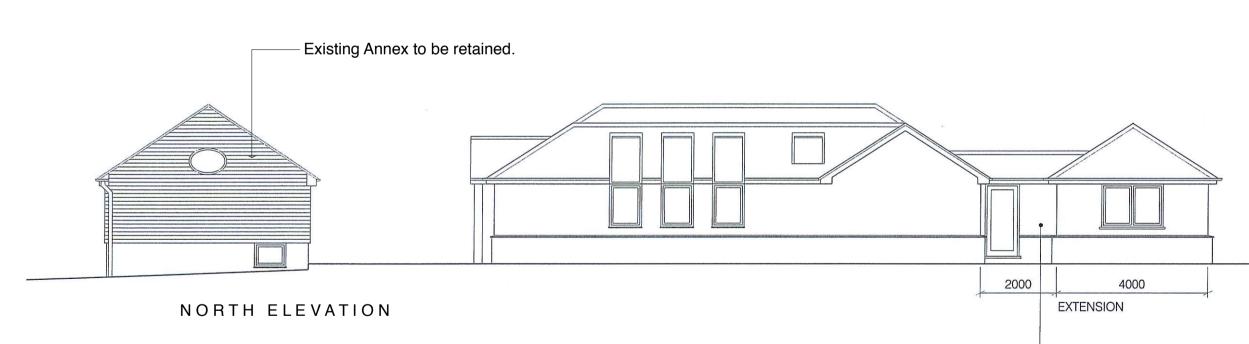
EXISTING DRAWINGS

WEST ELEVATION




NEW EXTENSION WITH RENDER WALL WITH WHITE FINISH AND CLAY TIL ROOF, AND WHITE FRAMED WINDOW TO MATCH EXISTING PROPERT








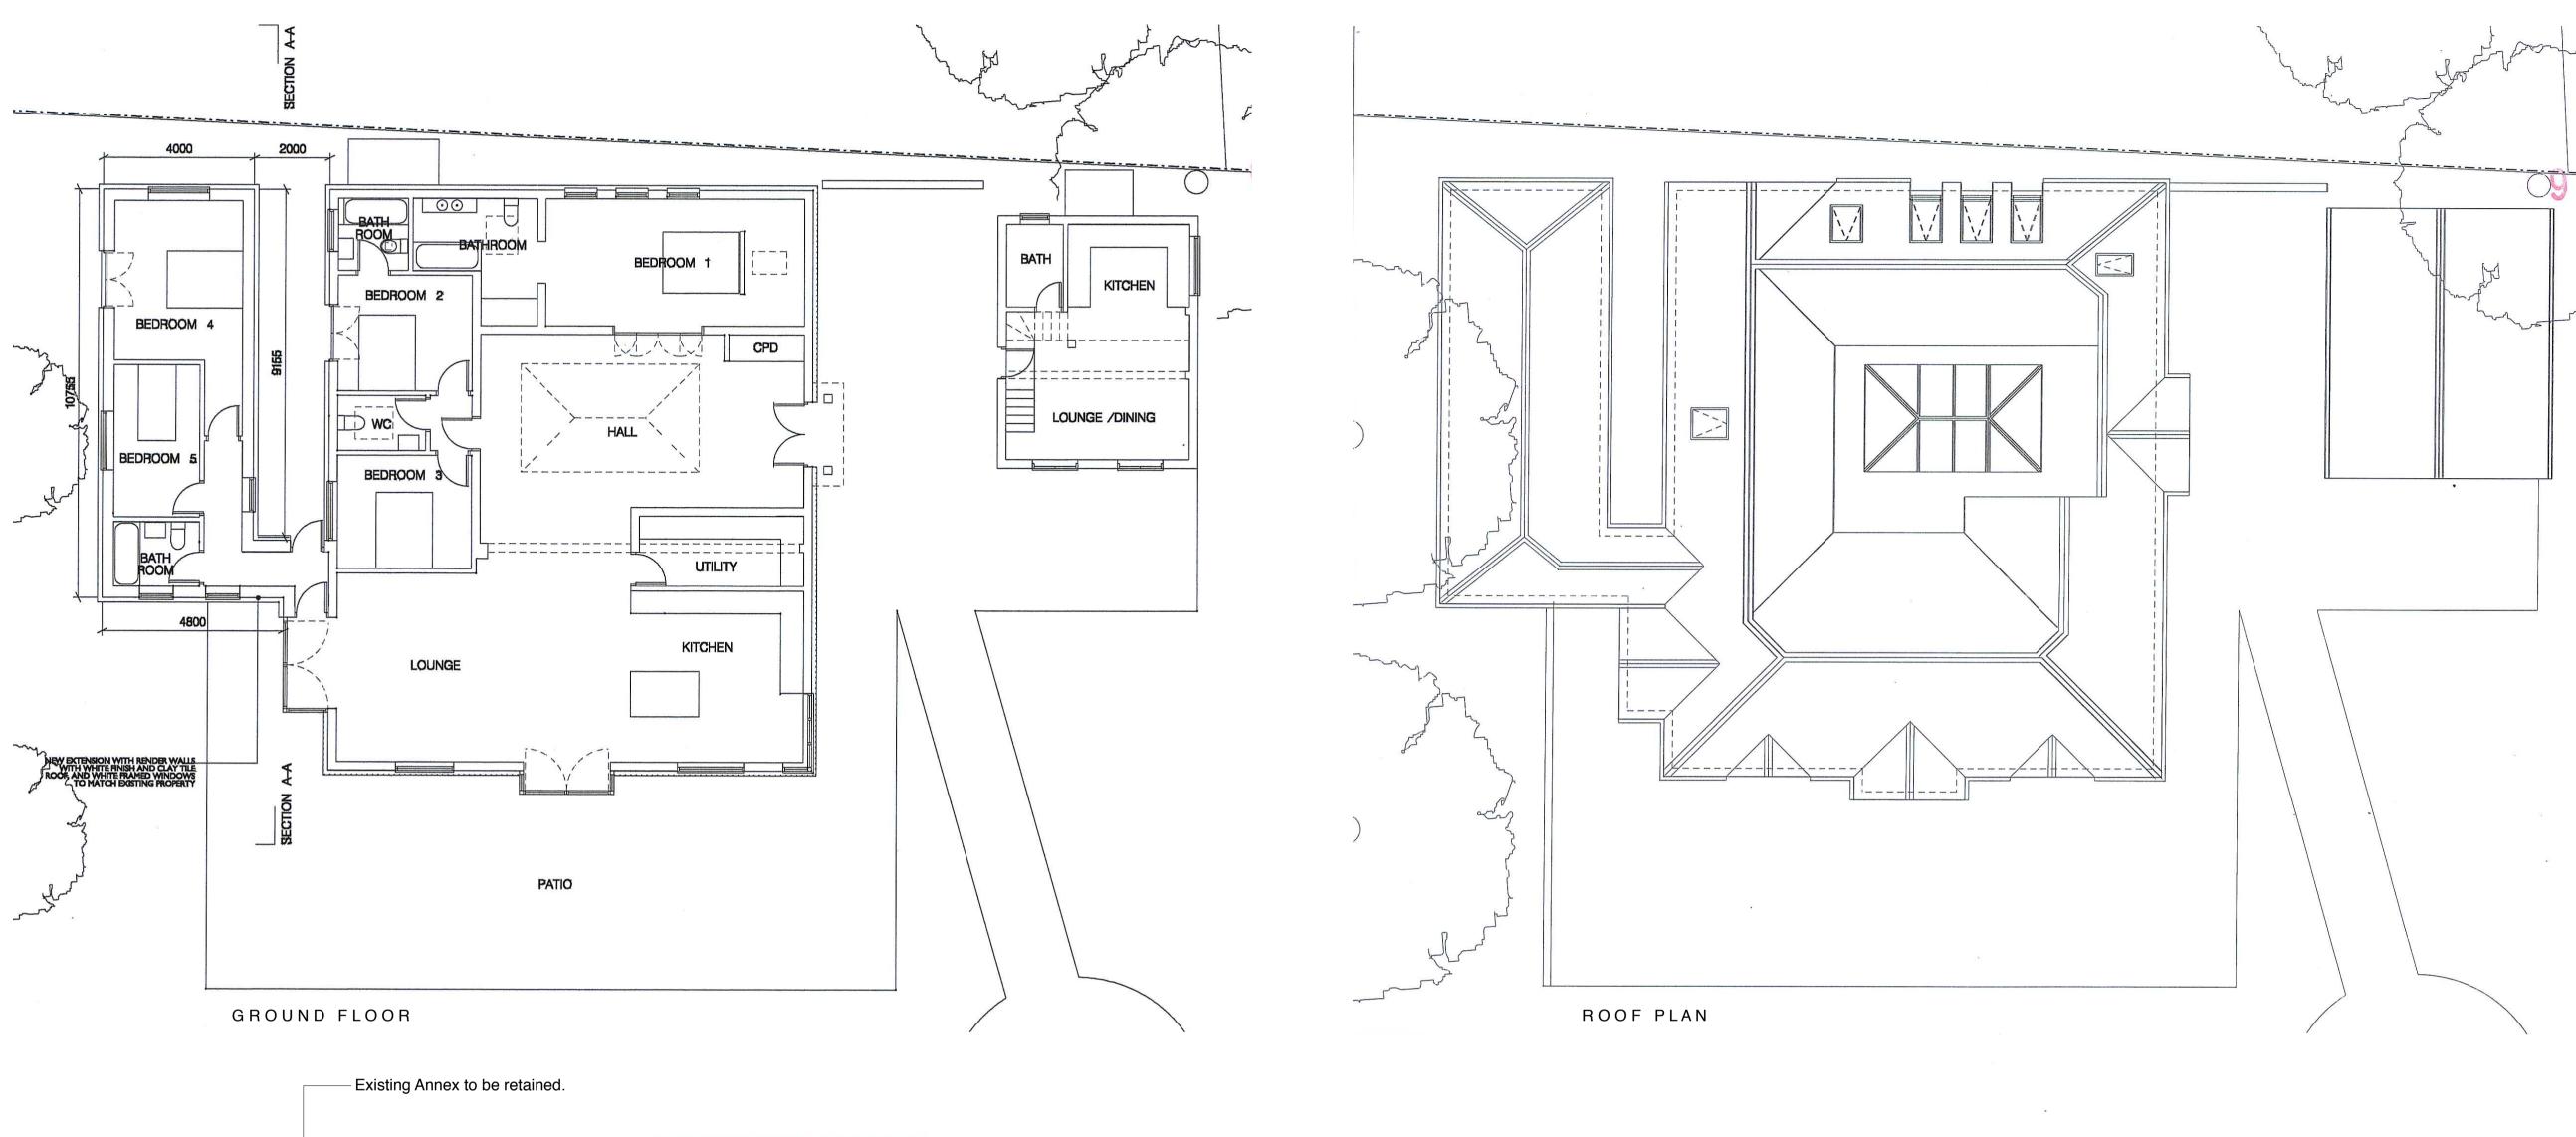

Coral Gables, Chorelywood WD3

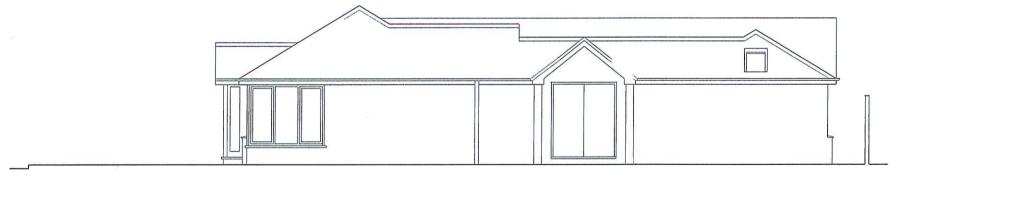

EAST ELEVATION

Existing Annex to be retained.



SOUTH ELEVATION



Project: Coral Gables Solesbridge Lane Chorleywood WD3 5SN Drawing: Existing Building Plans & Elevations ^{Scale:} 1:100@A1 / 1:200@A3 Drawing Number: 0201 ^{Date:} May 2021





Aerial photograph of the site.




Existing dwelling and annex.



Existing double garage to be demolished.



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TYPE A - NT1, NT2, NT3, NT4, NT5 & NT13

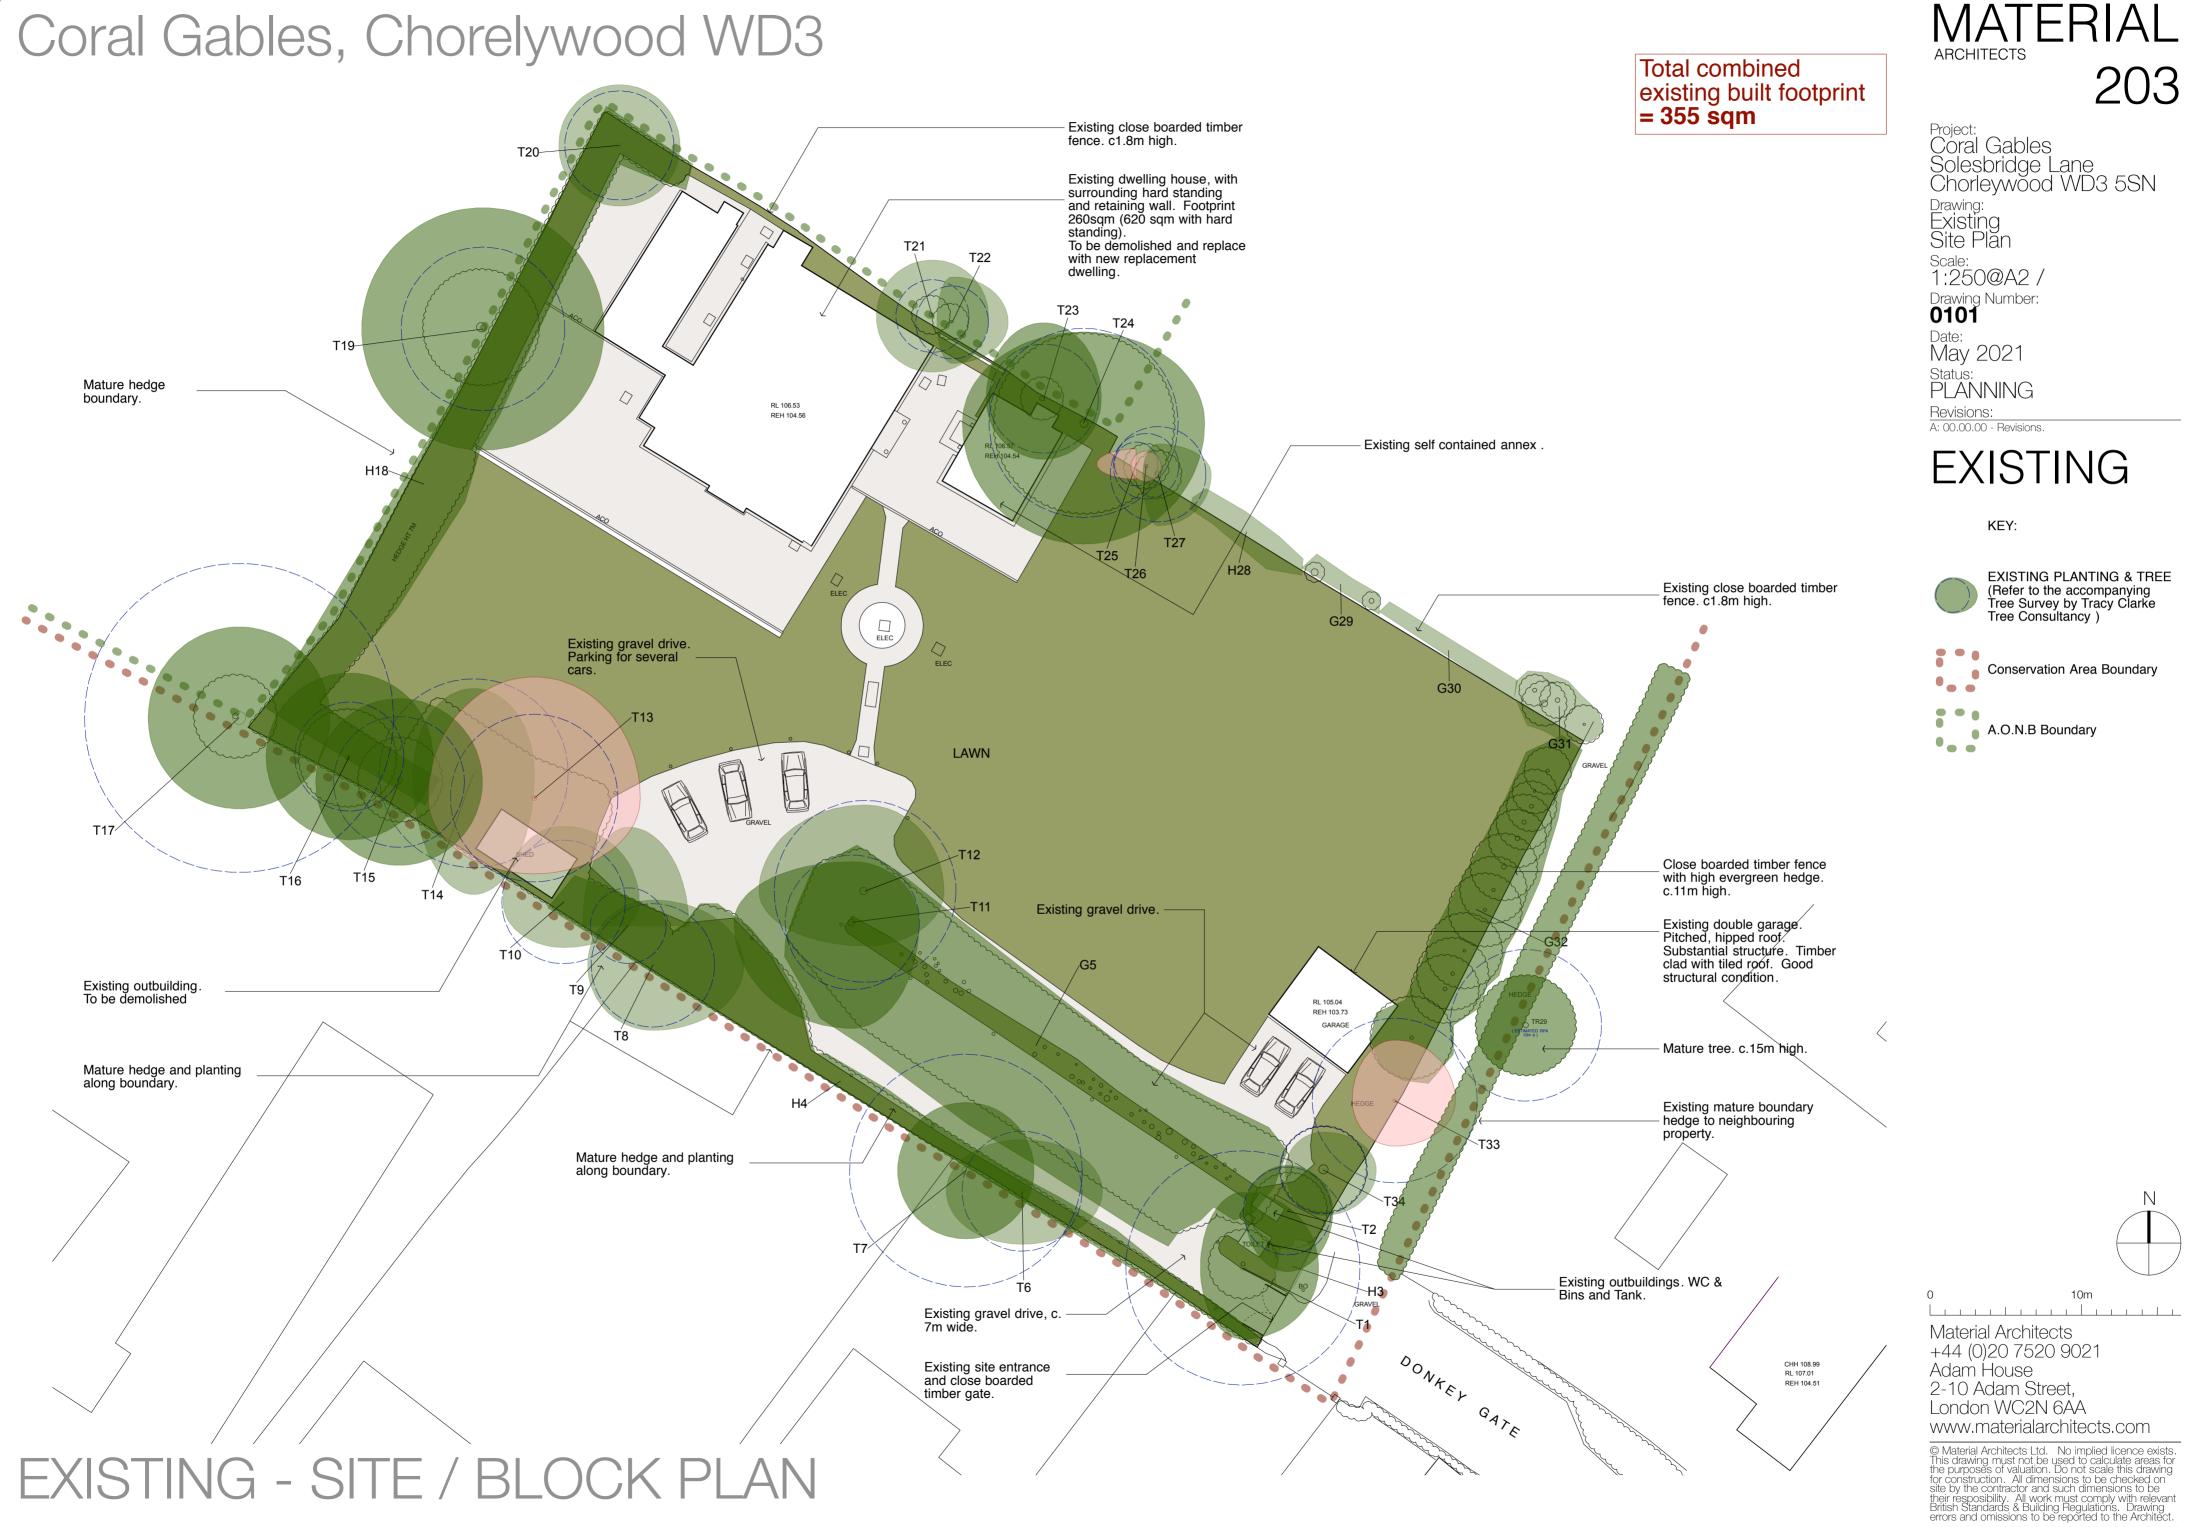NEW TREE. NATIVE ORNAMENTAL CHERRY BLOSSOM WILD CHERRY - Prunus Avium Maiden Tree 1.5+m

TYPE B - NT6 to NT12 Inc. SMALL FRUIT TREE.

APPLE: Malus Domestica Arthur Turner Malus Domestica Bramley Madien Tree 1.5+m

TYPE A - NH1 & NH4

NEW BOUNDARY / SCREEN HEDGE COMMON HORNBEAM - Carpinus Betulus

TYPE B - NH2 & NH3

NEW BOUNDARY HEDGE / GENERAL NATIVE MIXED: Quick Thorn Common Privet (European) Dogwood



NEW PLANTING

Shrubs & Multi-stem Bushes carefully chosen low level planting to enhance the boundary and front of plot 2 such as Blue Holly and Lilac Blossom.

NEW LAWN

Grass Hardy mix such as Tall Fescue (20%) & Perennial Ryegrass (80%).

SEDUM ROOF COVERING

Sedum Mat by www.sedumgreenroof.co.uk

Form: Proprietary pre-grown mat supplied containing a minimum 7No. different Sedum species.

GRAVEL DRIVE

Golden gravel, average 20mm.

PAVING

<u>MINIMAL</u> area of small format granite Cobble to dwelling approaches. Resin bonded Granite Cobble Setts. 100x100x50mm NATURAL SPLIT, DARK GREY, FINE GRAIN by www.granitesettsuk.co.uk



NESTING BOX. & BAT ROOST 1No. EACH PER DWELLING. WOODSTONE SPARROW TERRACE BY GARDENATURE WOODSTONE BEAUMARIS BAT BOX



EXTERNAL LIGHTING. SOLID OAK BOLLARD. STRATTON SINGLE STYLISH ECO -LED. Low level down lights only, facing away from the Conservation Area



VEHICLE CHARGING POINT (1 PER DWELLING)



ENTRANCE LIGHTING Subtle, integrated external lighting appropriate for a rural setting. No sub-urban street lighting.

























- Net gain of 10No. trees Poor condition trees removed only in accordance with the accompanying AIA.

NT5

NH1


- Net gain of over 60m of hedges NH2 and NH3 add significant amount of habitat and screening. No increase in 'domestic' fencing.
- Net gain of over 120 sqm of Sedum Roof Significant increase in habitat encourages greater bio-diversity and increases rainwater attenuation.
- Over 25m of enhanced boundary with the CA Driveway width reduced to allow enhanced planing to site edge along its boundary with the Conservation Area. Contributing positively to the wider setting.
- Site-wide reduction in rainwater run-off rates Net gain in site permeability and water attenuation

PROPOSED LANDSCAPE PLAN

- Over 550 sqm of lawn introduced





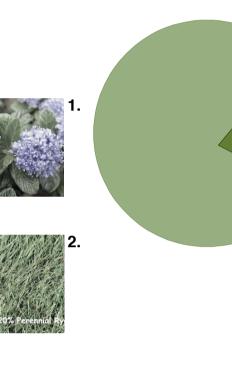





Project: Coral Gables Solesbridge Lane Chorleywood WD3 5SN Drawing: Proposed Landscape Plan Scale: 1:200@A1 / 1:400@A3 Drawing Number: **1105** ^{Date:} May 2021 Status: PLANNING Revisions:

KEY:

EXISTING PLANTING & TREE (Refer to the accompanying Tree Survey by Tracy Clarke Tree Consultancy)

PROPOSED NEW TREE



PROPOSED NEW HEDGE






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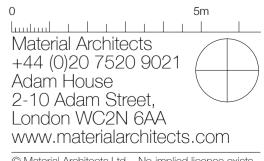
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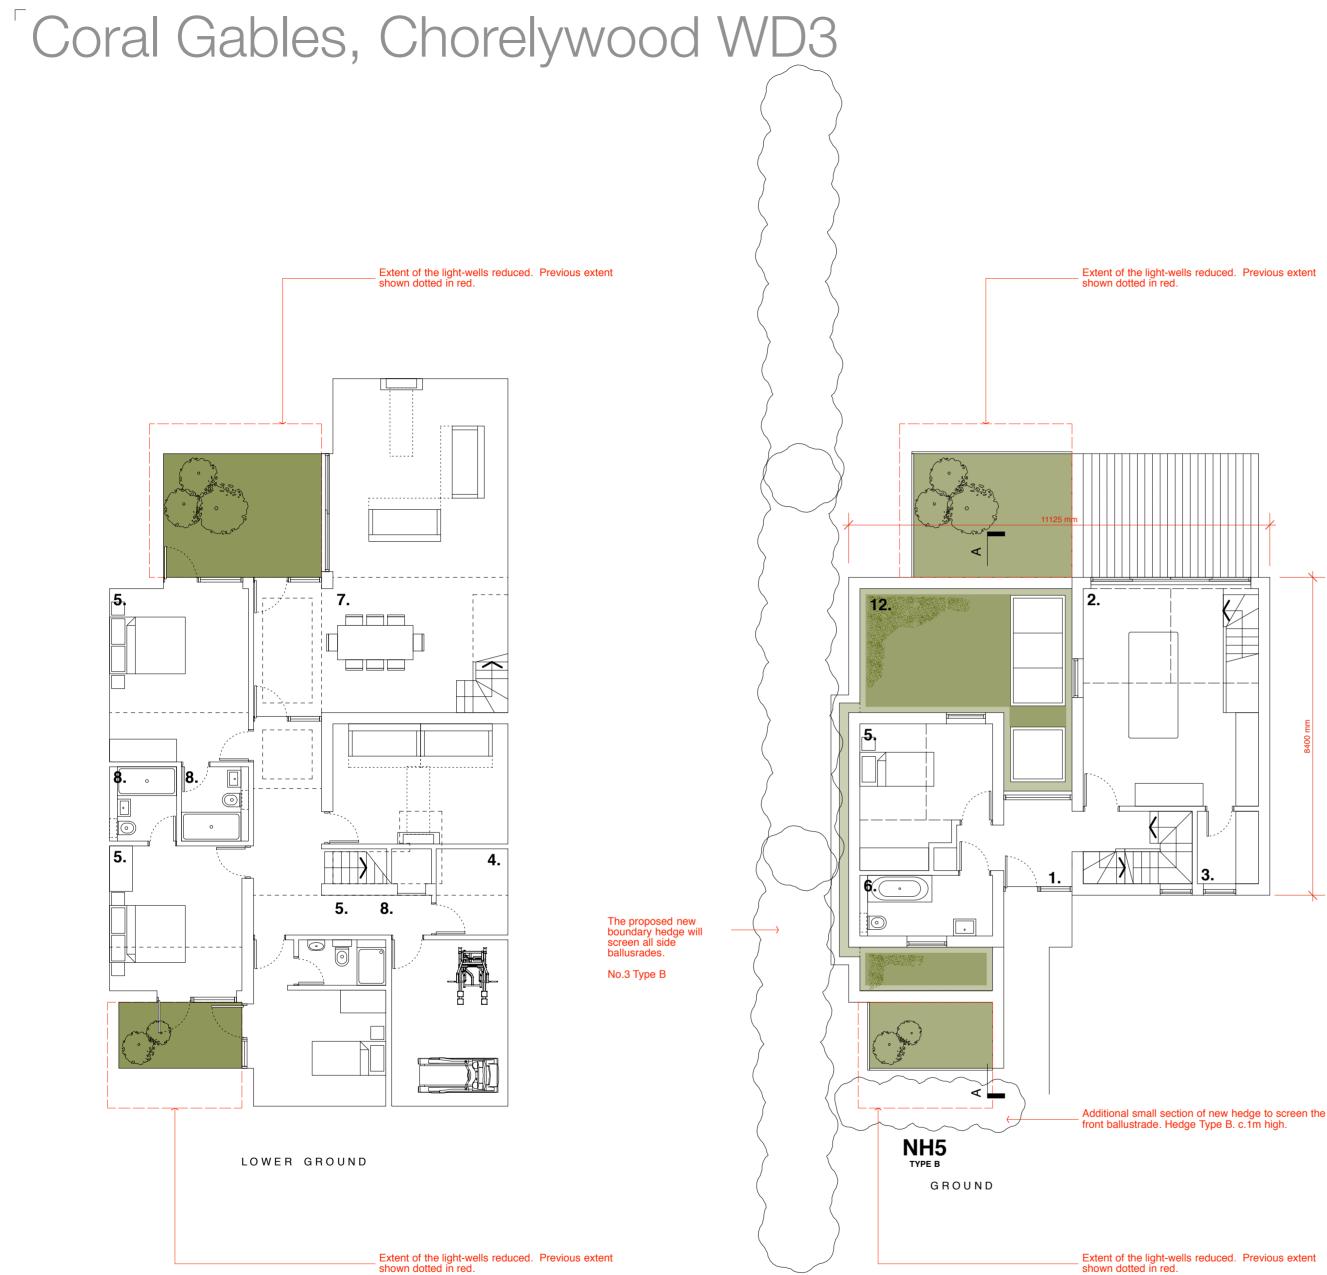





NEW DWELLING (PLOT 2) - ELEVATIONS

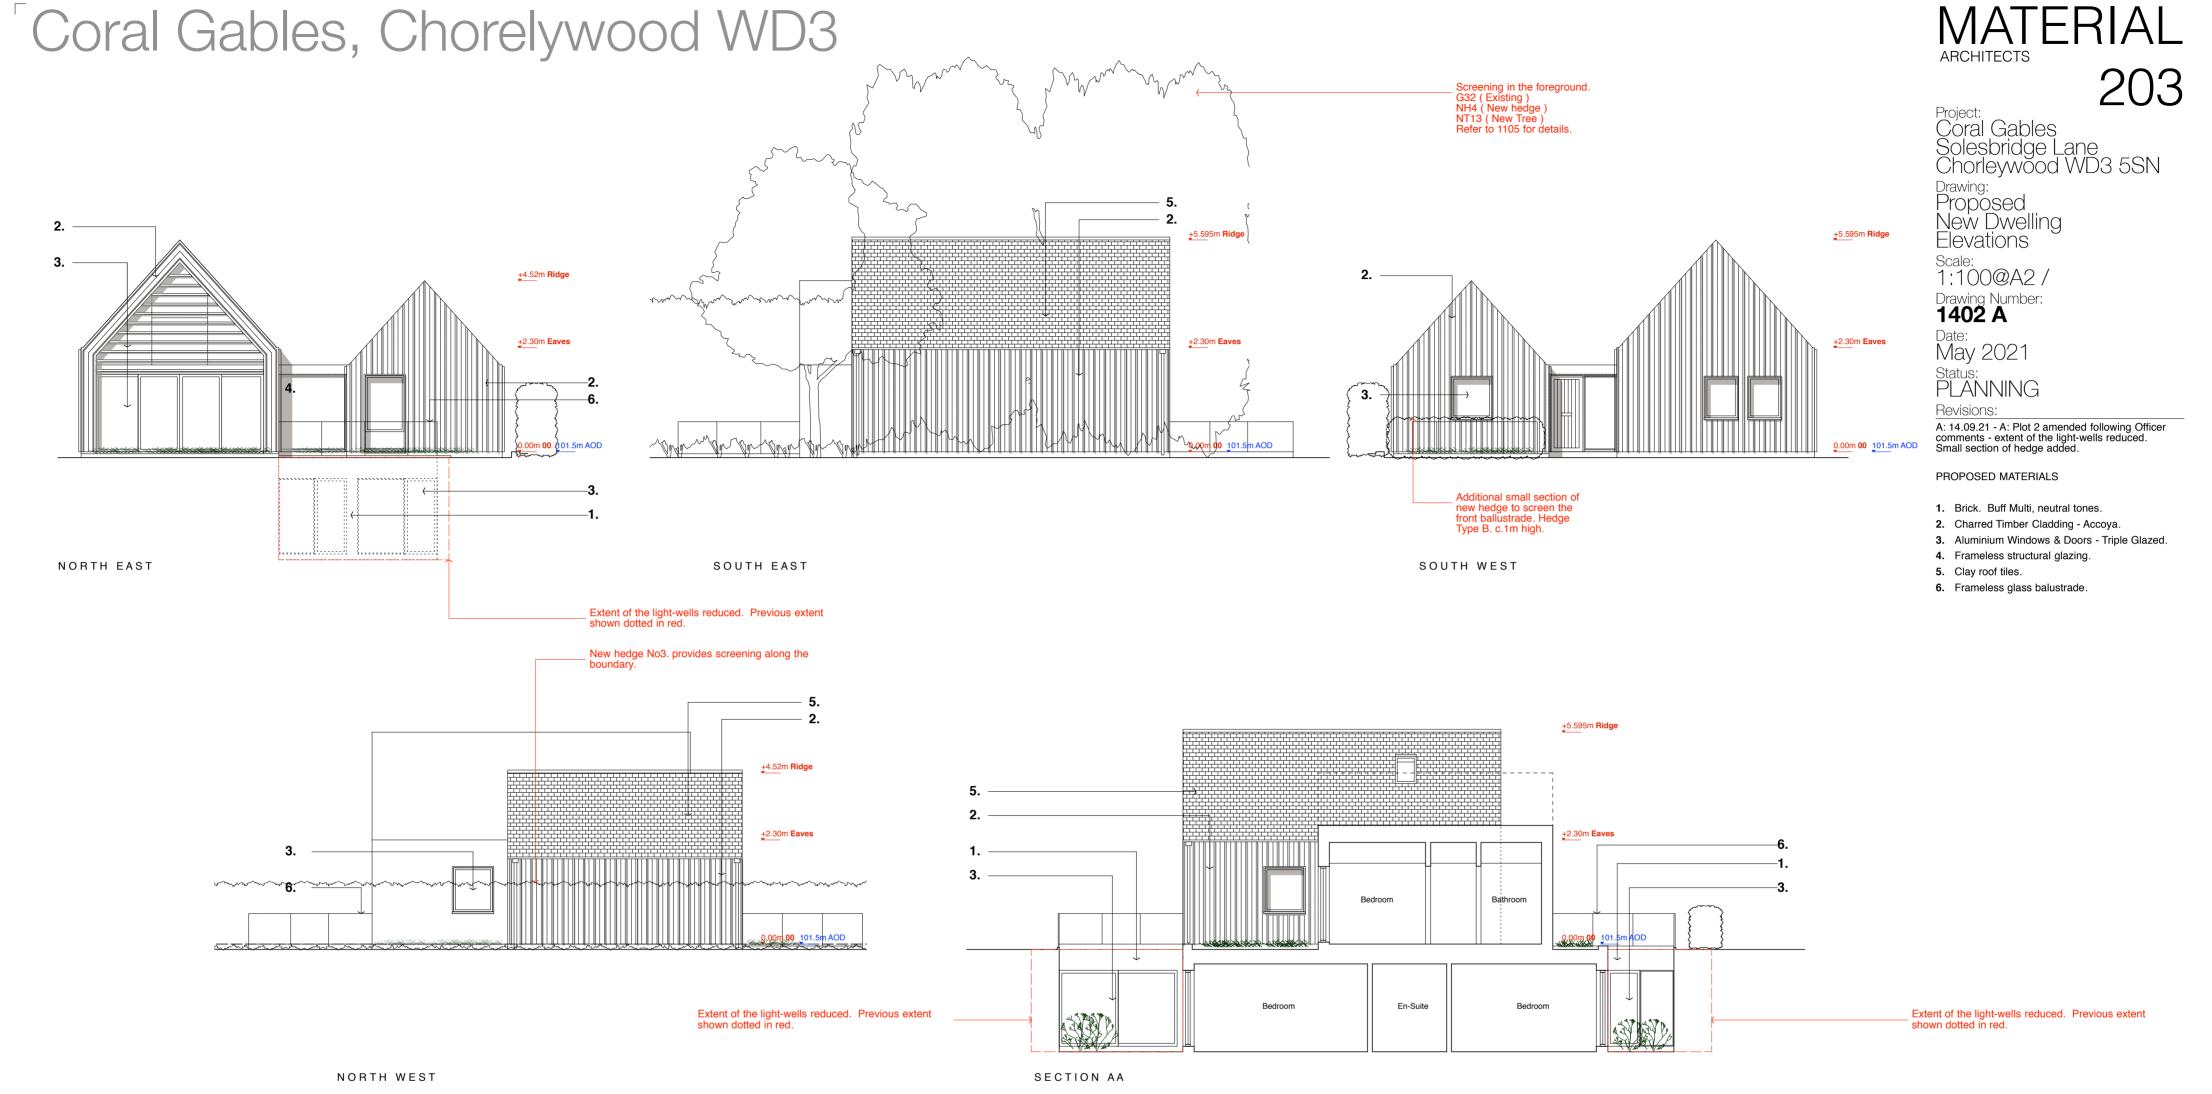


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NEW DWELLING (PLOT 2) - PLANS



VAULTED ROOF SPACE

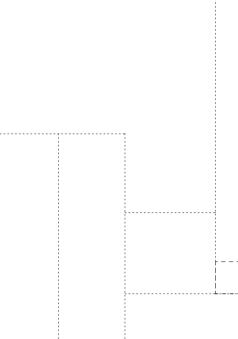

MATERIAL ARCHITECTS 203

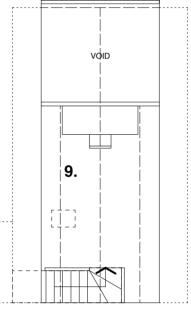Project: Coral Gables Solesbridge Lane Chorleywood WD3 5SN Drawing: Proposed

New Dwelling Plans Scale: 1:100@A2 /

Drawing Number: 1202 A

Date: May 2021 Status: PLANNING

Revisions:

A: 14.09.21 - A: Plot 2 amended following Officer comments - extent of the light-wells reduced. Small section of hedge added.

NOTES:

- 1. Entrance
- 2. Kitchen (Vaulted) 3. Utility

4. Storage

5. Bedroom

6. Bathroom

7. Living / Dining

8. En-Suite

9. Study mezzanine

10. Home Cinema

11. Gym

12. Sedum / Planted Roof

NOTES


Approximate GIA = 192 sqm (Limited headroom on mezzanine)



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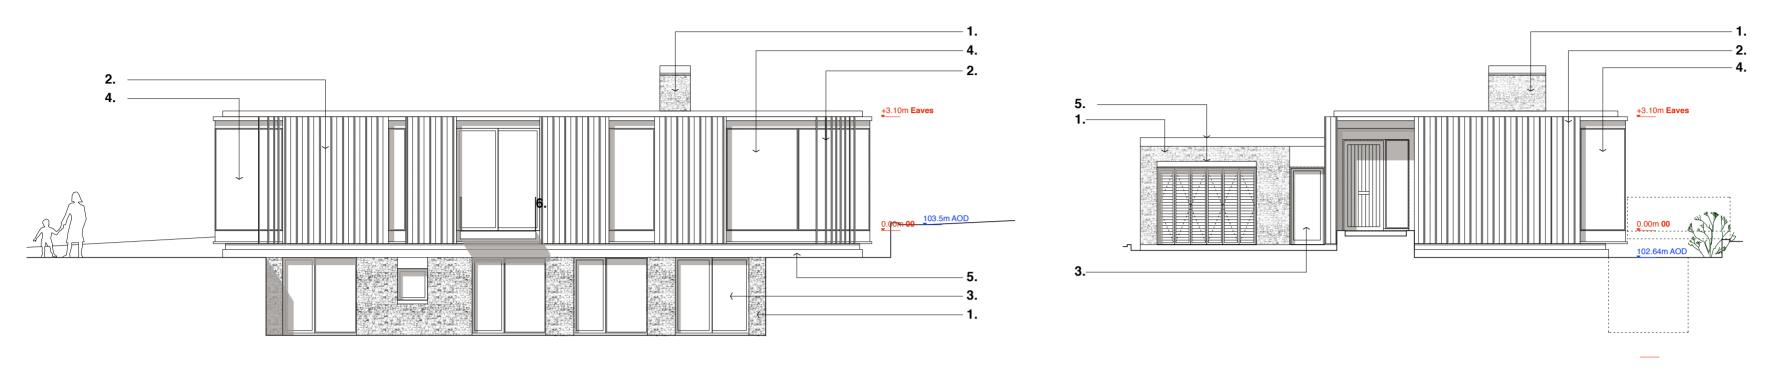




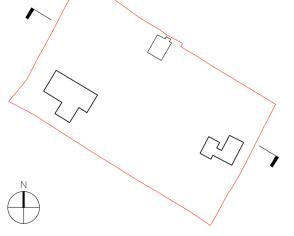


SITE SECTION - LOOKING SOUTH WEST





NORTH EAST

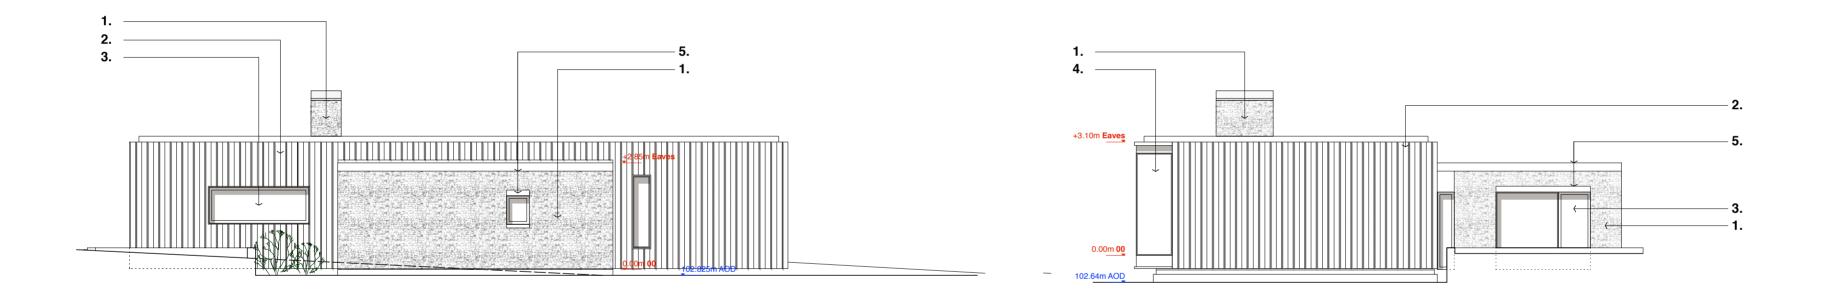

SOUTH WEST



Knapped Flint in contemporary houses. Delvendahl Martin Architects, Jestico + Whiles Architects

REPLACEMENT DWELLING (PLOT 1) - ELEVATIONS

SOUTH EAST

NORTH WEST



Examples of successful low-lying contemporary dwellings in sensitive landscape settings. Materials and treatment used to harmonise architecture with landscape. Strom Architects



Project: Coral Gables Solesbridge Lane Chorleywood WD3 5SN Drawing: Proposed

Replacement Dwelling Elevations

Scale: 1:100@A2 / Drawing Number: **1401 B**

Date:

May 2021 Status: PLANNING

Revisions: A: 14.09.21 - A: Basment and ground footprint reduced, eaves lowered, following Officer

comments.


B: 06.10.21 - B: Building revised to remove first floor following Officer Comments.

PROPOSED MATERIALS

- 1. Stone cladding / Knapped Flint.
- 2. Charred Timber Cladding Accoya. 3. Aluminium Windows & Doors - Triple Glazed.
- 4. Frameless Structural Glazing.
- 5. Concrete Fascia / Lintel.
- 6. Frameless glass balustrade.



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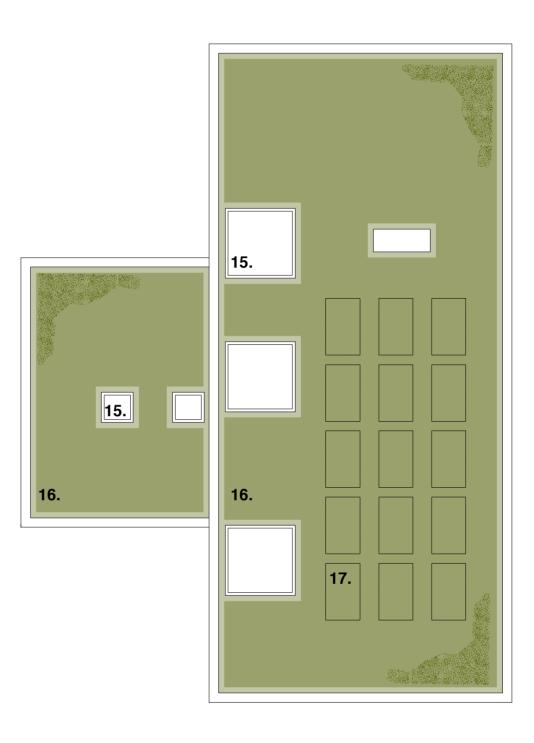

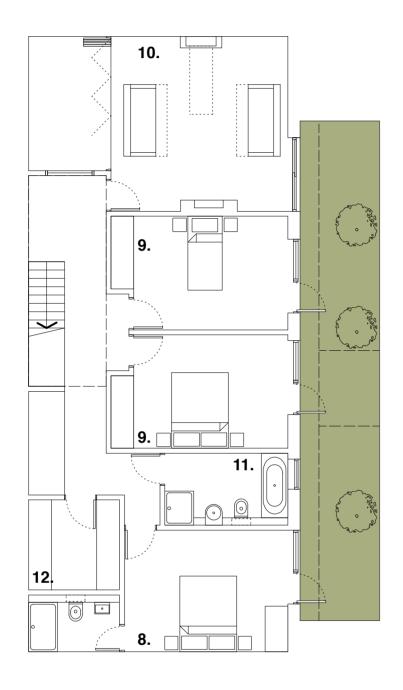
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LOWER GROUND

REPLACEMENT DWELLING (PLOT 1) - PLANS





ROOF



Project: Coral Gables Solesbridge Lane Chorleywood WD3 5SN ^{Drawing:} Proposed Replacement Dwelling Plans

Scale: 1:100@A2 /

Drawing Number: 1201 B

Date: May 2021 Status: PLANNING

Revisions:

A: 14.09.21 - A: Basment and ground footprint reduced following Officer comments.

B: 06.10.21 - B: Building revised to remove first floor following Officer Comments.

NOTES:

1. Entrance

2. Hall

- 3. Kitchen / Dining 4. Larder / Utility
- 5. Reception

6. Play Room / Bedroom

7 WC and Cloaks

8 Bedroom with En-Suite

9 Bedroom

10 Lounge / TV Room

11 Family Bathroom 12 Laundry / Plant

13 Study

14 Cycle Storage

15 Roof Light

16 Sedum Roof 17 PVs

NOTES:

Approximate GIA = 263 sqm



their resposibility. All work must comply with relevant British Standards & Building Regulations. Drawing errors and omissions to be reported to the Architect.